City of York



York Fire Department Interior Renovations

Request for Proposal RFP #2024-0002

DUE: MONDAY, MAY 20, 2024, at 2:00pm

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MAY 20, 2024 REQUEST FOR PROPOSAL RFP # 2024-0002

The City of York, SC is soliciting Requests for Proposals by Contractors to submit proposals for interior remodel to the City of York Fire Department. The original (1) and two (2) copies **FOR A TOTAL OF THREE** (3) **PROPOSALS**, and one (1) digital copy on a flash drive marked "York Fire Department Interior Renovations I" will be received in a sealed envelope not later than 2:00 PM on Monday, May 20th, 2024, at:

The City of York
Attn: Amy Craig, Municipal Clerk
York City Hall
P.O. Box 500 (Postal Service)
10 N. Roosevelt St. (UPS, Fed Ex, or in-person)
York, SC 29745

Facsimile and/or electronic proposals will not be accepted. Proposals received after the announced time and date of receipt, by mail or otherwise, will be returned unopened. Nothing herein is intended to exclude any responsible firm or in any way restrain or restrict competition. On the contrary, all responsible firms, local, faith-based, minority-owned, and female-owned, are encouraged to submit a proposal.

The City of York reserves the right to reject any or all of the proposals and/or to waive informalities for any or all proposals. Any proposal submitted MUST be signed by an individual authorized to bind the offer.

Mandatory Pre-Bid Meeting

Monday, May 6, 2024, 10:00am

14 North Roosevelt St. York, SC 29745

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INTRODUCTION

Proposal Requested

The City of York is in search of a Contractor for;

Interior renovation of the current fire station located at 14 N. Roosevelt St., York, SC, 29745. This is to include, but is not limited to, debris removal of areas highlighted in the proposed plans, additions to the kitchen, new office area, and storage area, all countertops replaced in all restrooms, repainting all areas within the fire station, and updating all floors.

See the Project Scope and Plan Set included within this RFP for complete details.

Project Background

The Chief of Fire will lead the project with assistance from the Planning Director with oversight from the City Manager. Final approval will be required through the City Council. Throughout the process, additional engagement with other staff, engineer of record, and other associated parties will be expected. Communication with and to those groups will be coordinated through the project leader, the Chief of Fire.

SCOPE OF WORK

Task 1-Demolition Plan

Refer to the City of York, SC Interior Renovation Plans (Attachment #2)

Task 2-Kitchen Renovation & Addition

Refer to the City of York, SC Interior Renovation Plans (Attachment #2)

Task 3-Office Addition

Refer to the City of York, SC Interior Renovation Plans (Attachment #2)

Task 4-Storage Addition

Refer to the City of York, SC Interior Renovation Plans (Attachment #2)

Task 5-Restroom Counter Tops

Refer to the City of York, SC Interior Renovation Plans (Attachment #2)

Task 6-General Painting

Refer to the City of York, SC Interior Renovation Plans (Attachment #2)

Task 7-Finish Floor Plan

Refer to the City of York, SC Interior Renovation Plans (Attachment #2)

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GENERAL INFORMATION AND INSTRUCTIONS

Procurement Process

This RFP is not a bid. In the event the City elects to negotiate a contract with the successful, responsive proposer, any contract shall contain, at a minimum, requirements. In its sole discretion, the City reserves the right to reject all submissions, reissue a subsequent RFP, terminate, restructure, or amend this procurement process at any time. The final selection and contract negotiation rests solely with the City. No direct or indirect contact with the Mayor of the City of York or City of York Council members will be allowed. The City reserves the right to reject the proposal if such contact is made.

Questions

Questions are allowed and encouraged in order to clarify the contents of this RFP or to offer any proposed changes. The City will not accept telephone calls or visits regarding this RFP. No interpretation shall be binding unless in writing from the City of York.

Requests for additional information and questions must be submitted in writing via letter or email to Michael Regal, City of York, PO Box 500, York, SC 29745, or email: mregal@yorksc.gov. The deadline for additional information and **questions** is **Monday, May 13, 2024, at 12:00 pm**.

The City may accept the RFP from one of the Contractors from the list or negotiate with the Contractors as appropriate. The City reserves the right to negotiate all final terms and conditions of any agreements entered into.

PROPOSAL FORMAT

Scope of Work Describe the Contractor's approach to accomplishing the objectives stated in the RFP and identify the scope of work. The Contractor is encouraged to include suggestions, which may enhance the project or streamline the scope of work and improve cost-effectiveness. State your assumptions clearly.

Work Timeline Include a proposed timeline showing the estimated length of time needed to complete the interior renovations. Time estimates should be expressed in days/weeks without reference to a specific starting date. The timeline should identify when the Notice to Proceed is executed and substantial completion, and include a duration of project closeout, which will be submitted to City staff.

Statement of Qualifications and Relevant Experience: Include any related supplemental information concerning key personnel or team experience that may be relevant. Please identify the project manager and principal contact assigned to the project (it is strongly preferred that they be one and the same person).

Contract Information Contract agreements will be finalized between the City and the Contractor after completing the selection procedure. At that time, a payment schedule will be negotiated.

Signature The proposal shall be signed by an official authorized to bind the Contractor and shall contain a statement guaranteeing that the proposal/cost estimate is valid for sixty (60) days.

References List at least three (3) reference clients for whom similar or comparable services have been performed. Include the primary contact person's name, mailing address, and telephone number.

Cost Summary The cost summary shall be submitted in a separate sealed envelope. All costs should reflect "not to exceed" figures with all applicable sales tax included. Fee schedules, including hourly rates for the prime Contractor and all subcontractors, meetings, and reproduction costs, should accompany the cost summary as applicable. Lastly, all line items associated with the bid tab are to be bid in the Lump Sum unit with applicable sales tax included.

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Insurance Requirements The successful respondent will be required to maintain current insurance for the duration of the project. Insurance policies shall be maintained for Errors and Omissions, General Liability, Automobile, and Worker's Compensation.

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PROPOSAL SUBMITTAL

Three (3) labeled copies of the proposal (one (1) original copy and two (2) hard copies plus one (1) digital copy) with separate sealed and labeled envelopes containing the cost estimate and fee schedules must be received by the City Hall office, Attn: Amy Craig (10 N. Roosevelt St, York, SC, 29745) **no later than 2:00 pm on Monday, May 20, 2024**. Late postmarks will not be accepted. The City of York will not pay for any costs incurred by any Contractor resulting from the preparation or submittal of a proposal in response to the RFP. The City reserves the right to modify or cancel in part, or in its entirety, the RFP. The City reserves the right to reject any or all proposals and to waive any defects and/or informalities.

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ATTACHMENTS

- 1. Bid Tabulation
- 2. Plan Set

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Attachment #1 Bid Tab





Fire Station Interior Renovations City of York, South Carolina

Facility Address: 14 N. Roosevelt St., York, SC, 29745

			7 Te	6 Te	5 Te	4 Te	3 Te	2 Te	1 Te	Item T
			Task 7 F	Task 6 (Task 5 F	Task 4	Task 3 (Task 2	Task 1 [Туре
		Finish Floor Plan	General Painting	Restroom Counter Tops	Storage Addition	Office Addition	Kitchen Renovation & Addition	Demolition	Item Description	
			1	1	1	1	1	1	1	Quantity
			LS	LS	LS	LS	LS	LS	LS	Unit
Total	Contingency 10%	Subtotal								Unit Price
										Amount


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Attachment #2 Plan Set

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THE CITY OF YORK

YORK FIRE STATION HEADQUARTERS INTERIOR RENOVATIONS



FINISH WOOD

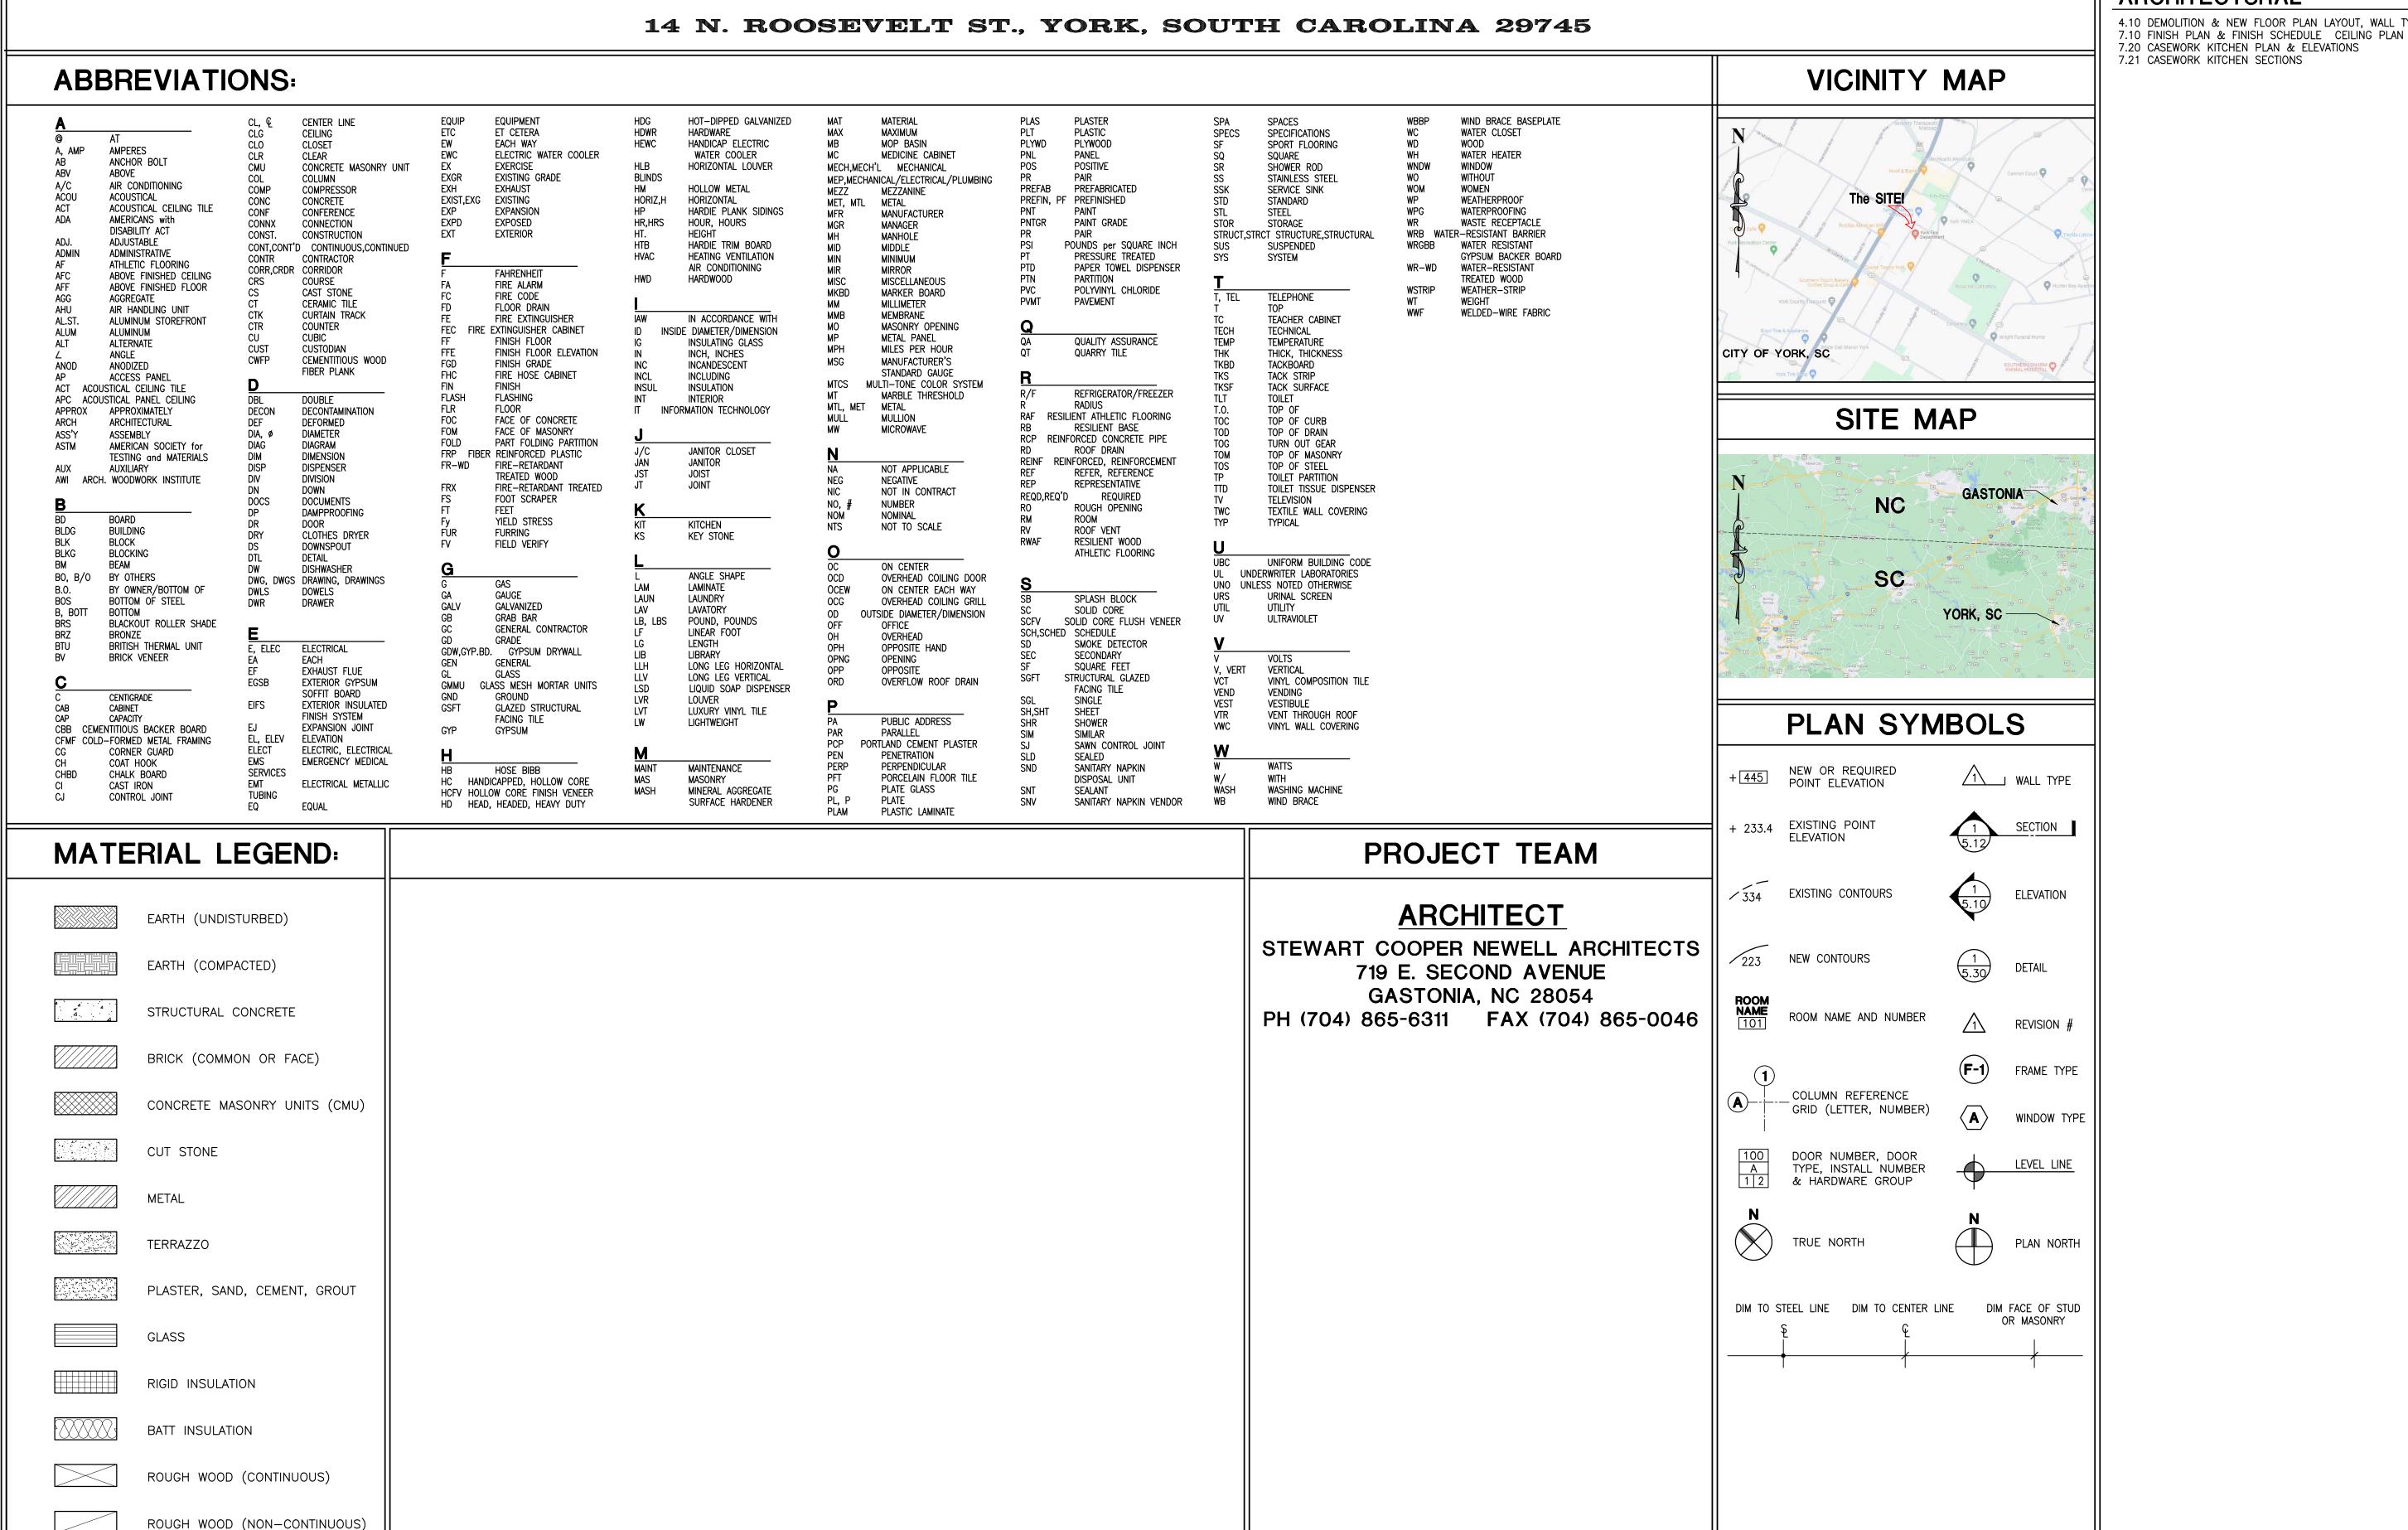INDEX OF DRAWINGS:


GENERAL

LIFE SAFETY

BUILDING CODE SUMMARY & APPENDIX 'B' EXPANSION JOINTS & UL DETAILS

ARCHITECTURAL

4.10 DEMOLITION & NEW FLOOR PLAN LAYOUT, WALL TYPE & PLAN NOTES

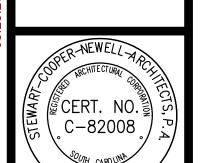


Project No.

DATE: 02.29.2024 DRAWN by: jbj CHECKED by: KCN

REVISIONS:

O O SC

Stewart

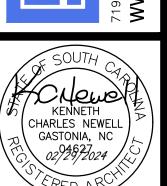

DE YORK, SC FIRE STATION DQUARTERS RENOVATION ROOSEVELT ST., YORK, SOUTH CAROLINA 29745

CONTACT: <u>Ken C. Newell</u> (704) 865-6311 NAME LICENSE # TELEPHONE # E-MAIL DESIGNER Stewart Cooper Newell Architects Ken C. Newell ___04627___ 704.865.6311 knewell@scn-architects.com_ Architectural Landscape ____ (___)_____ ____ Electrical Fire Alarm Plumbing ____ (___)_____ Sprinkler-Standpipe Structural _____(___)______ Retaining Walls >5' High N/A ("Other" should include firms and individuals such as truss, pre-engineered, interior designers, etc.)

2018 SC CODE FOR: □ New Construction □ Addition □ Renovation □1st Time Interior Completion ☐Shell/Core \square Phased Construction – Shell/Core 2018 SC EXISTING building code: Prescriptive □Chapter 14 □Level II □Level III **Alteration:** □Level I ☐ Change of Use ☐ Historic Property CONSTRUCTED: (date) 1999 CURRENT OCCUPANCY(S) (Ch. 3): B/S-2 /R-2 PROPOSED OCCUPANCY (S) (Ch. 3): RENOVATED: (date) _____ RISK CATEGORY (table 1604.5) Current: \Box I \square III \square III \Box IV Proposed: \Box I

BASIC BUILDING DATA Construction Type: □I-A (check all that apply) □I-B ⊠II-B \square III-A $\Box V$ -B **Sprinklers:** □No □Partial ⊠Yes ⊠NFPA 13 □NFPA 13R □NFPA 13D Standpipes: $\boxtimes No \quad \Box Yes \quad Class \, \Box I$ □II □III □Wet □Dry Fire District: ⊠No □Yes (Primary) Flood Hazard Area: ⊠No □Yes **Special Inspections Required:** ⊠No □Yes

Gross Building Area Table EXISTING (SQ FT) NEW (SQ FT) RENO/ALTER (SQ FT) SUB-TOTAL

ALLOWABLE AREA Assembly \square A-1 \square A-2 \square A-3 \square A-4 \square A-5

350 S.F Existing

Business Educational Factory ☐ F-1 Moderate ☐ F-2 Low Hazardous \square H-1 Detonate \square H-2 Detonate \square H-3 Combust \square H-4 Health \square H-5 HPM Institutional \square I-1 Condition \square 1 \square 2 \square I-2 Condition \square 1 \square 2 \square I-3 Condition \square 1 \square 2 \square 3 \square 4 \square 5 □ I-4 Mercantile

Residential \square R-1 \square R-2 \square R-3 \square R-4 ☐ S-1 Moderate ☐ S-2 Low ☐ High-piled Storage \square Parking Garage \square Open \square Enclosed \square Repair Garage Utility and Miscellaneous Accessory Occupancy Classification(s): Residential (R-2), Business (B)

construction, so determined, shall apply to the entire building.

Primary Occupancy Classification(s):

Incidental Uses (Table 509): N/A Special Uses (Chapter 4 – List Code Selections): N/A Special Provisions (Chapter 5 – List Code Selections): N/A Mixed Occupancy: ☐ No ☐ Yes Separation: 2 Hr. Exception: __EXISTING____ ☑ Non-Separated Occupancies (508.3) The required type of construction for the building shall be determined by applying the height and area limitations for each of the applicable occupancies to the entire building. The most restrictive type of

☐ Separated Occupancies (508.4) See below for area calculations. For each story, the area of the occupancy shall be such that the sum of the ratios of the actual floor area of each use divided by the allowable floor area for each use shall not exceed 1.

<u>Actual Area of Occupancy A</u> + <u>Actual Area of Occupancy B</u> ≤ 1 Allowable Area of Occupancy A Allowable Area of Occupancy B <u>N/A</u> + <u>N/A</u> + = <u>N/A</u> ≤1.00

BLDG AREA PER TABLE 506.24 AREA FOR FRONTAGE ALLOWABLE AREA PER STORY (ACTUAL) INCREASE^{1,5} STORY OR LINLIMITED^{2,3} EXISTING EXISTING BUILDING FIRST STORAGE (S-2) 6,606 104,000 EXISTING EXISTING BUILDING FIRST RESIDENTIAL (R-2) 64,000

¹ Frontage area increases from Section 506.3 are computed thus: a. Perimeter which fronts a public way or open space having 20 feet minimum width = $\underline{N/A}$ (F) b. Total Building Perimeter = N/A (P)

c. Ratio (F/P) = N/A (F/P)d. W = Minimum width of public way = N/A (W) e. Percent of frontage increase $I_f = 100 [F/P - 0.25] \times W/30 = N/A$ (%) Unlimited area applicable under conditions of Section 507. Maximum Building Area = total number of stories in the building x D (506.2).

ALLOWABLE HEIGHT

	ALLOWABLE (TABLE 504)	SHOWN ON PLANS	CODE REFERENCE						
Building Height in Feet (Table 504.3)	55'	Existing No Change	N/A						
Building Height in Stories (Table 504.4)	3	Existing No Change	N/A						
¹ Provide code reference if the "Show on Plans" quantity is not based on Table 504.3 or 504.4. ² The maximum height of air traffic control towers must comply with Table 412.2.1.1.									

DETAIL# DESIGN# DESIGN#FOR DESIGN#
AND FOR RATED RATED FOR RATED
SHEET# ASSEMBLY PENETRATION JOINTS DISTANCE including columns, girders, trusses Bearing Walls North EXISTING West EXISTING South EXISTING Interior Nonbearing Walls and Exterior walls West South Interior walls and partit Including supporting be and joists Floor Ceiling Assembly Column Supporting Floor Roof Construction, including supporting beams and joists Roof Ceiling Assembly Column Supporting Roof Shaft Enclosures - Exit N/A N/A N/A N/A Shaft Enclosures – Other Corridor Separation N/A 2 HR KISTING EXISTING EXISTING Occupancy/ Fire Barrier Party/ Fire Wall Separati N/A N/A Smoke Barrier Separation N/A N/A Smoke Partition 1 HR 1 HR EXISTING EXISTING Tenant/ Dwelling Unit/ Sleeping Unit Separation

PERCENTAGE OF WALL OPENING CALCULATIONS

DEGREE OF OPENINGS PROTECTION (TABLE 705.8)

LIFE SAFETY SYSTEM REQUIREMENTS

□ No ⊠ Yes Emergency Lighting: □ No ⊠ Yes Exit Signs: □ No ⊠ Yes Fire Alarm: Smoke Detection Systems: Carbon Monoxide Detection: □ No ⊠ Yes

⊠ No □ Yes Panic Hardware:

LIFE SAFETY PLAN REQUIREMENTS Life Safety Plan Sheet #: 1.00

☑ Fire and/or smoke rated wall locations (Chapter 7) ☐ Assumed and real property line locations (if not on the site plan) ☐ Exterior wall opening area with respect to distance to assumed property lines (705.8) ☑ Occupancy types for each area as it relates to occupant load calculation (Table 1004.5)

 □ Occupant loads for each area ☑ Common path of travel distances (1006.2.1)

 □ Dead end lengths (1020.4) ☑ Clear exit widths for each exit door

Maximum calculated occupant load capacity each exit door can accommodate based on egress width (1005.3)

 □ Actual occupant load for each exit door ☐ A separate schematic plan indicating where fire rated floor/ceiling and/or roof structure is provided for purposes of occupancy separation and supporting construction for a fire barrier/fire partition/smoke barrier.

 \square Location of doors with panic hardware (1010.1.10) ☐ Location of doors with delayed egress locks and the amount of delay (1010.1.9.8)

☐ Location of doors with electromagnetic egress locks (1010.1.9.9)

☐ Location of doors equipped with hold-open devices ☐ Location of emergency escape windows (1030)

 \Box The square footage of each fire area (202) ☐ The square footage of each smoke compartment for Occupancy Classification I-2 (407)

☐ Note any code exceptions or table notes that may have been utilized regarding the items above Section/Table/Note

ACCESSIBLE DWELLING UNITS (SECTION 1107)

			(~-		,		
TOTAL UNITS	Accessible Units Required	ACCESSIBLE UNITS PROVIDED	TYPE A UNITS REOUIRED	TYPE A UNITS PROVIDED	TYPE B UNITS REQUIRED	TYPE B Units Provided	TOTAL ACCESSIBLE UNITS PROVIDED
37/4	TEQUIES	TROVIDED	TEQUIEES	TROTIBLE	TESQUITED	TROVIDED	
N/A	-	-	-	-	-	-	-

ACCESSIBLE PARKING (SECTION 1106)

			(-)		
LOT OR PARKING	TOTAL # OF PAR	KING SPACES	# OF ACC	CESSIBLE SPACES PRO	OVIDED	TOTAL#
AREA	REQUIRED	PROVIDED	REGULAR WITH	VAN SPACI	ES WITH	ACCESSIBLE PROVIDED
			5' ACCESS AISLE	132" ACCESS AISLE	8' ACCESS AISLE	PROVIDED
TOTAL	PARKING EX	KISTING				

PLUMBING FIXTURE REQUIREMENTS (TABLE 2902.1)

USE		WA	ATERCLOSE	ETS	URINALS	LAVATORIES SHO		SHOWERS/ DRINKING FOUNTAI		FOUNTAINS	
		MALE	FEMALE	UNISEX		MALE	FEMALE	UNISEX	TUBS	REGULAR	Accessible
SPACE	EXIST'G	2	3	1	1	3	3	1	4	1	1
	NEW	-	-	-	-	-	-	-	-	-	-
	REQ'D	1	1	-	-	1	1	-	1	1	1

SPECIAL APPROVALS

Special Approval: (Local Jurisdiction, State Fire Marshal, DHEC, ICC, etc., describe below)

ENERGY SUMMARY PLEASE PROVIDE A BUILDING ENVELOPE COMCHECK

ENERGY REQUIREMENTS:

The following data shall be considered minimum and any special attribute required to meet the **South Carolina** Energy Conservation Code shall also be provided. Each Designer shall furnish the required portions of the project information for the plan data sheet. If performance method, state the annual energy cost for the standard reference design vs annual energy cost for the proposed design.

Existing building envelope complies with code: \square No \square Yes (The remainder of this section is not applicable)

GENERAL LIFE SAFETY NOTES

FIRESTOP AROUND ALL PIPE, CONDUIT, DUCTWORK AND ANY OTHER PENETRATIONS THROUGH RATED WALLS. PENETRATIONS OF NON-RATED PARTITIONS AND FLOORS SHALL BE FIRESTOPPED WITH NON-COMBUSTIBLE MATERIAL.

ALL FIRE RATED PARTITIONS MUST BE STENCILED WITH RED SPRAY PAINT IN THE CON-CEALED SPACE ABOVE THE CEILING WITH THE WORDS: "FIRE AND SMOKE BARRIER" 12" HIGH. STENCILING SHALL BE APPLIED AT 20'-0" O.C. STAGGER THE STENCILING ON OPPOSITE CORRIDOR WALLS. SEE SHEET 1.XX.

PROVIDE NON COMBUSTIBLE BLOCKING SECURELY ANCHORED IN ALL WALLS BEHIND ALL TOILET ACCESSORIES, BASE CABINETS, WALL CABINETS, VISUAL DISPLAY BOARDS AND ALL OTHER SURFACE MOUNTED ITEMS. PROVIDE NON COMBUSTIBLE FRAMING SECURELY ANCHORED TO WALL FRAMING TO PROVIDE ANCHORING SURFACE FOR ITEMS RECESSED IN WALLS.

COORDINATE ALL WALL FINISHES, IE GYP. BD.-PAINTED, BACKER BD.-TILE, WITH SHEET 7.10 PRIOR TO INSTALLATION.

PARTITIONS THAT TERMINATE JUST ABOVE THE FINISH CEILING MUST BE BRACED WITH ALTERNATING ANGLED KICKER STUDS AT 4'-0" O.C. THAT EXTEND FROM THE TOP OF THE PARTITION TO THE BUILDING STRUCTURE AND BE SECURELY ANCHORED.

LEGEND

→ X EXIT DISCHARGE

XX MIN. RATED DOOR, SEE DOOR TYPES

WALL TYPE (SEE SHEET 4.10)

(O.L.= XX) OCCUPANT LOAD

1. ALL WALLS ARE TYPE 1 U.N.O. IN THE PLAN. 2. SEE SHEET 1.70 & 1.71 FOR WALL TYPES AND NOTES.

SEE FINISH PLAN 7.10 & 7.11 FOR ALL WALL FINISHES.

OCCUPANCY CLASS & KEY

BUSINESS (B) 5.153 SF


BUSINESS (B)

BUSINESS B = 18 PEOPLE WIDTH REQ'D: $18 \times 0.2 = 3.6$ " 34" PROVIDED = 170 MAX OCC. RESIDENTIAL (R-2) 482 SF

1 - HOUR RATED WALL

2 - HOUR RATED WALL

KEY PLAN

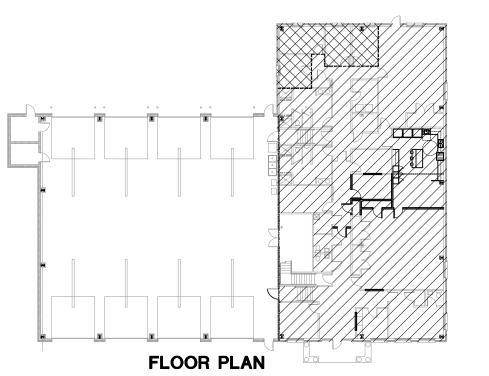

C-82008 CASTONIA, N. © STEWART-COOPER-NEWELL ARCHITECTS, P.A.

Project No.

DATE: 02.29.2024

CHECKED by: KCN

DRAWN by: jbj

REVISIONS


THIS DRAWING IS THE PROPERTY STEWART-COOPER-NEWELL ARCHITECTS, AND IS SUBJECT TO FEDERAL COPYRILAWS. THIS DRAWING MAY NOT REPRODUCED, PUBLISHED OR USED IN WAY WITHOUT THE WRITTEN PERMISSION STEWART-COOPER-NEWELL ARCHITECTS,


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Stewa

*CHeur CHARLES NEWELL GASTONIA, NC


Sheet No.



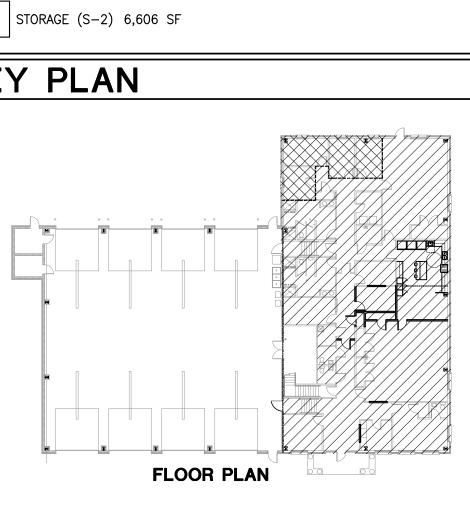

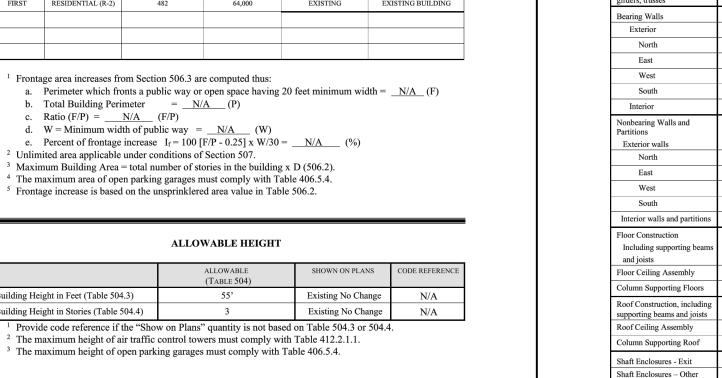Incidental Use Separation

* Indicate section number permitting reduction

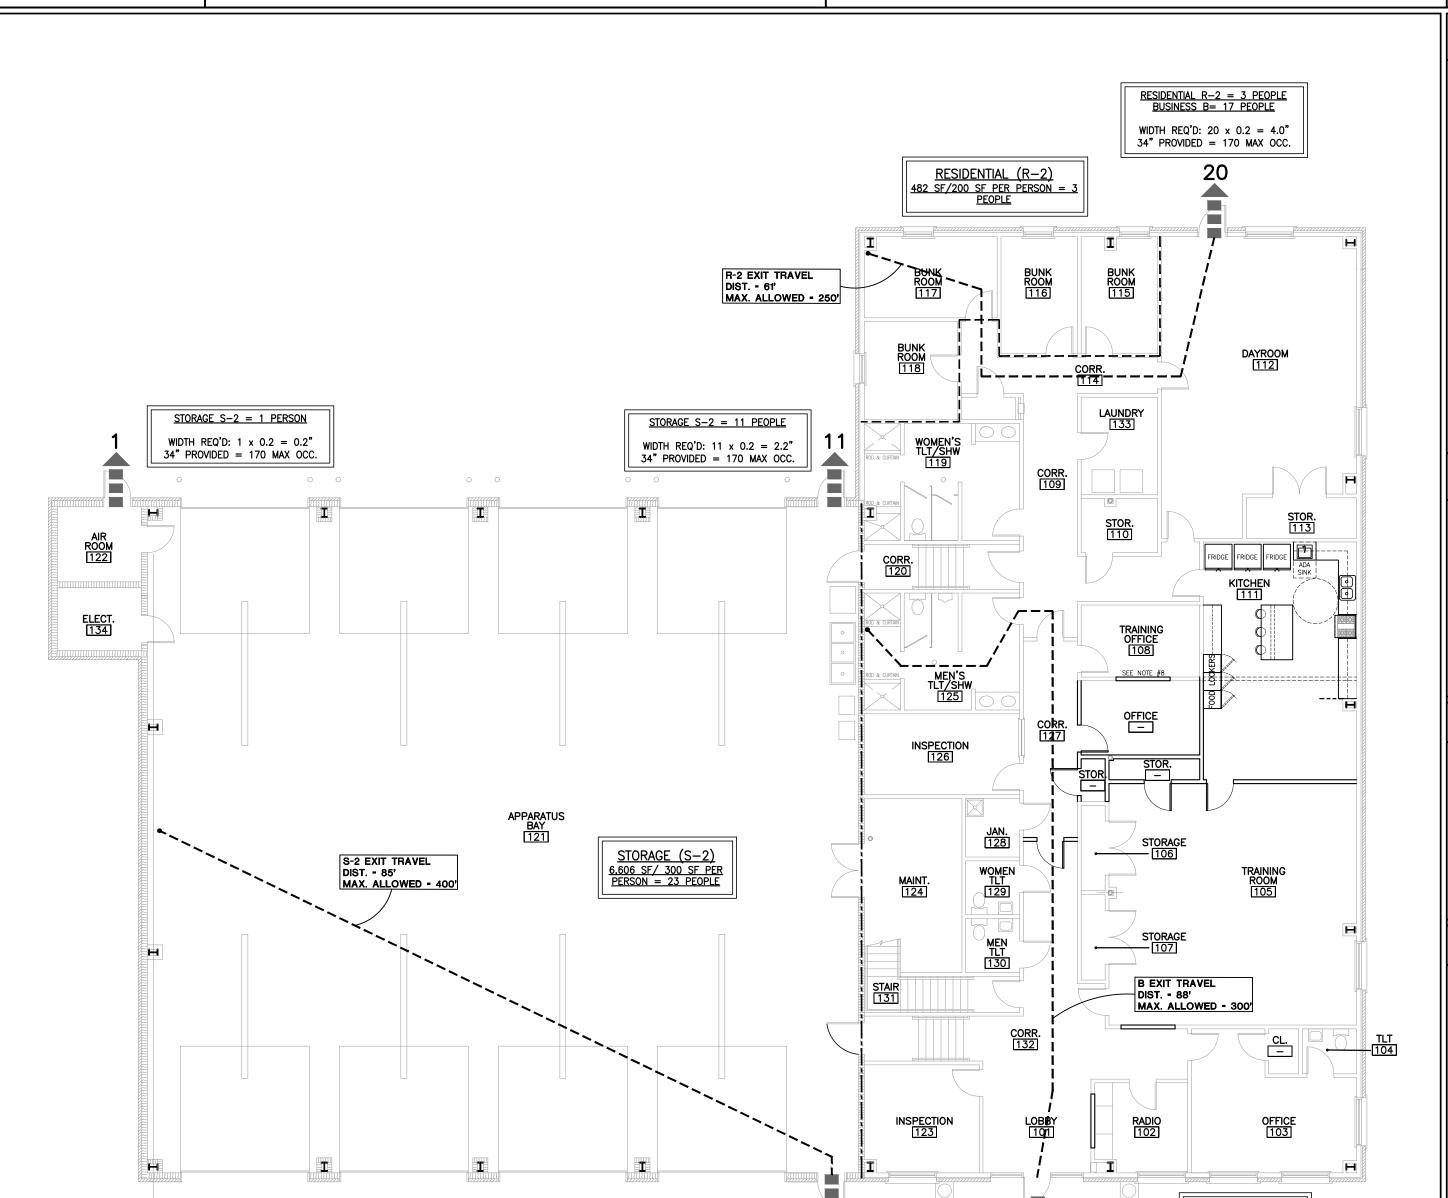



STORAGE S-2 = 11 PEOPLE

WIDTH REQ'D: $11 \times 0.2 = 2.2$ " 34" PROVIDED = 170 MAX OCC.

1) LIFE SAFETY PLAN

SCALE: 1/8" - 4' 2"

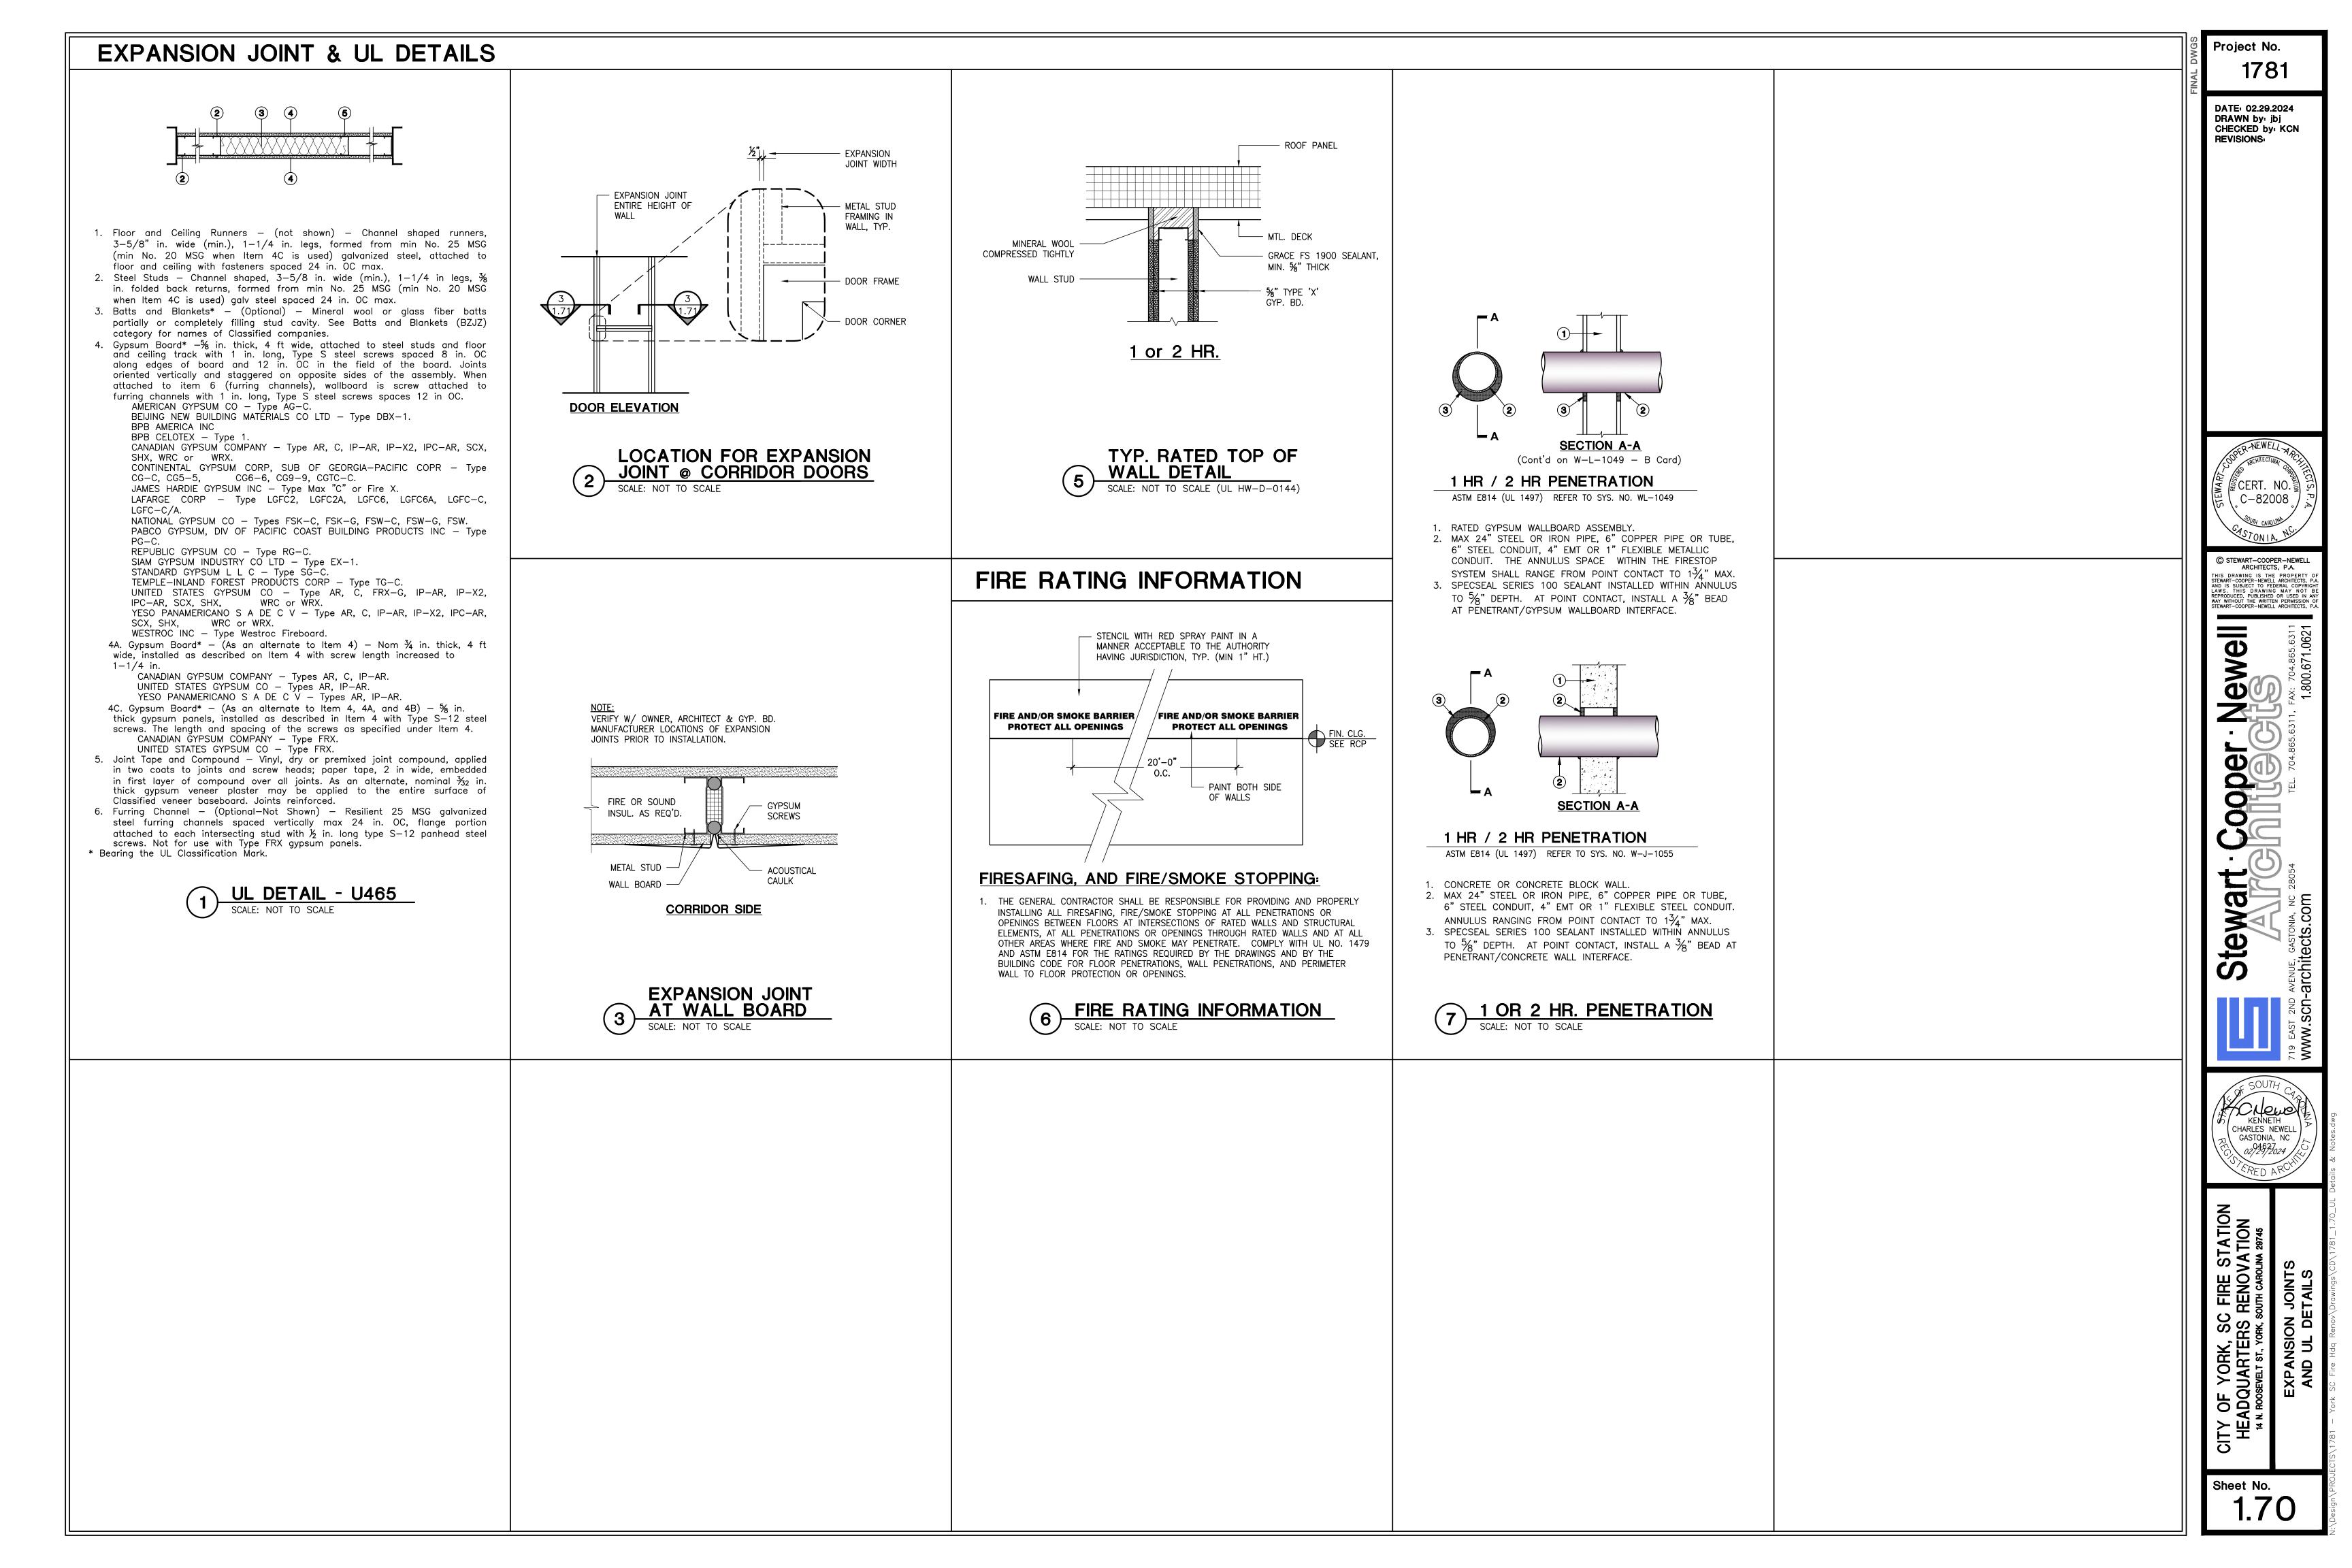

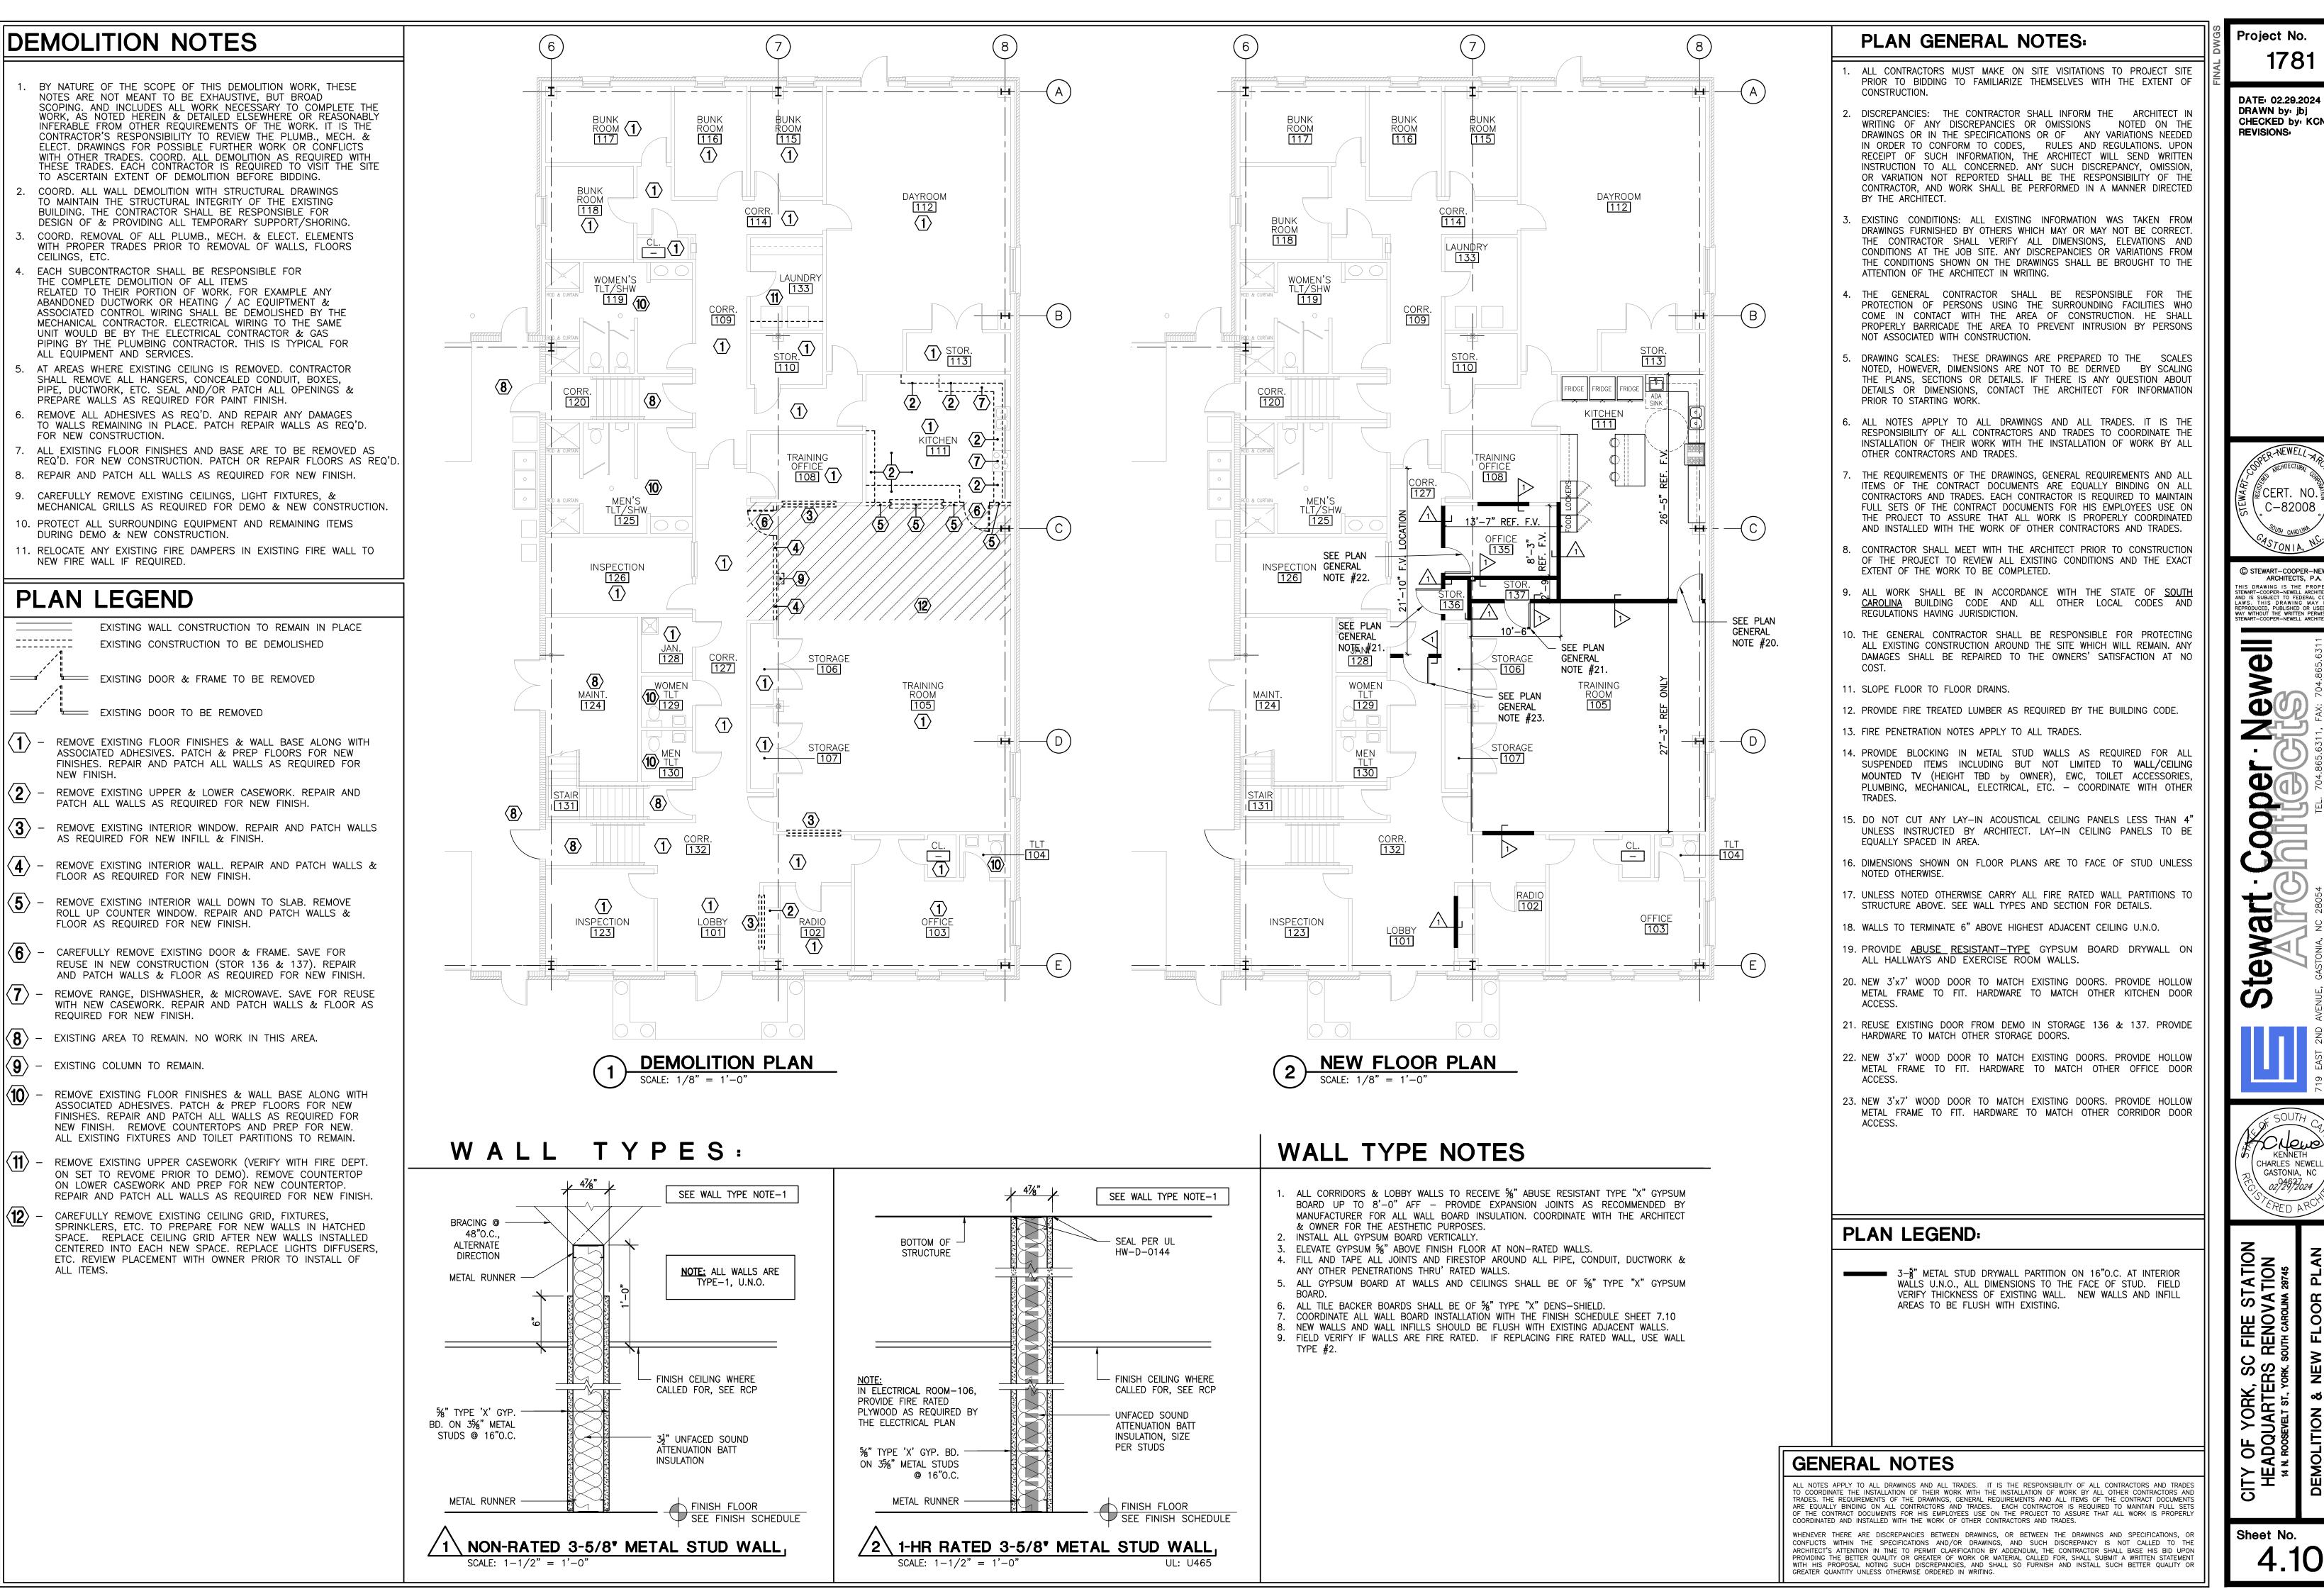

Project No.

1781

DATE: 02.29.2024 DRAWN by: jbj CHECKED by: KCN REVISIONS:

© CERT. NO C-82008

© STEWART-COOPER-NEWEL ARCHITECTS, P.A. DRAWING IS THE PROPE

PORCELAIN FLOOR TILE (NOTED AS PFT)

PFT-1 DALTILE COLORBODY PORCELAIN - UNITY ASHGREY P405 - UNPOLISHED, 12"x24" TILE (TOILET FLOORS) 6" COVE BASE TO MATCH AROUND PERIMETER OF FLOOR.

LUXURY VINYL TILE (NOTED AS LVT-) 20 mil.

LVT-1 SHAW, COVER+ENVELOP, COVER (4140V), V2 SURETY 05057, 7"x48" (FIELD)

LVT-2 SHAW, COVER+ENVELOP, COVER (4140V), V3 REFUGE 05111, 7"x48" (ACCENT)

CARPET TILE (NOTED AS CPT-)

CPT-1 KINETEX J&J FLOORING, AGAINST THE GRAIN, COLOR: 2820 RYE, SIZE: 12"x48" TO BE INSTALLED IN ASHLAR PATTERN.

PAINTS (NOTED AS PT-) SHERWIN WILLIAMS

PT-1 SW 7072 ONLINE, EGGSHELL FINISH (FIELD WALL)

PT-2 SW 7074 SOFTWARE, EGGSHELL FINISH (ACCENT WALL OR CEILING)

PT-3 SW 7072 ONLINE, EPOXY SEMI-GLOSS FINISH

HOLLOW METAL DOORS & FRAMES PAINT COLOR

HMDF SW 7505 MANOR HOUSE, EPOXY PAINT IN SEMI-GLOSS FINISH. PRIME AND PAINT ALL EXISTING AND NEW HOLLOW METAL DOOR FRAMES.

RESILIENT BASE (NOTED AS RB-)

TARKETT 4" RUBBER WALL BASE WITH TOE, 63 BURNT UMBER B. SHOULD WRAP AROUND THE CORNER GUARDS.

COUNTERTOP FINISHES (NOTED AS CTR-)

SOLID SURFACE, WILSONART COUNTERTOP, CARBON AGGREGATE. DUSK ICE9203CE, 12mm THICK. SEE SHEET 7.20 FOR ADDITIONAL DETAIL (FOR ALL KITCHEN (NOT THE ISLAND), RESTROOM VANITY, LAUNDRY COUNTERTOPS

QUARTZ, WILSONART, LYRA Q2001, 20mm THICK. (FOR KITCHEN ISLAND COUNTERTOP ONLY)

CEILING FINISHES (NOTED AS CLG-) See RCP @ 6.10

GENERAL PAINTING

and FINISH NOTES:

9. GROUT JOINT @ $\frac{3}{16}$ " FOR ALL FLOOR & WALL TILES.

2. PRIME ALL SURFACES PRIOR TO APPLYING FINAL PAINT FINISHES.

WILL BE SELECTED BY THE ARCHITECT DURING CONSTRUCTION.

4. PROVIDE TRANSITION STRIP OF APPROPRIATE DESIGN AT ALL CONDITIONS.

6. PAINT ALL VENTS, GRILLES, PIPING, ETC. TO MATCH ADJACENT PAINT COLOR. 7. PROVIDE SAMPLES FOR REVIEW & APPROVAL PRIOR TO APPLICATION & INSTALLING

FLOORS.

ALL FINISHES.

SELECTED.

MATERIALS.

OCCUR UNDER DOOR, (TYP).

PROVIDE GRAY MARBLE THRESHOLDS AT ENTRANCES TO ALL ROOMS WITH HARD TILE

3. ALL SURFACES SHALL RECEIVE A FINISH WHETHER NOTED OR NOT. ITEMS NOT NOTED

5. VERIFY FLOOR TRANSITION/JOINER STRIPS PRIOR TO INSTALLATION. INSTALLATION TO

8. PAINT ALL BULKHEADS WITH PT-X UNLESS NOTED OTHERWISE IN RCP & CASEWORK

A) TOILET FLOOR TILES - MAPEI ULTRACOLOR PLUS FA, SANDED, COLOR: TO BE

10. "FEATHER" FLOORING SUBSTRATE AS REQUIRED AT TRANSITIONS OF DIFFERING

CLG-1 ARMSTRONG KITCHEN ZONE-673, LAY-IN CEILING PANELS WITH 15" PRELUDE SUSPENSION SYSTEM, 24"x24"x2" THK.

CLG-2 EXISTING CEILING TO REMAIN


REPLACE EXISTING FLUSH MOUNTED CORNER GUARD COLOR PIECE. COLOR TO BE SELECTED DURING CONSTRUCTION FROM THE FULL RANGE OF MANUFACTURER'S COLORS.


BUNK ROOM 116 ROOM 115 CPT-1 PT-1 RB-1 PT-1 CLG-2 ▼告 LVT-1 RB-1 PT-1 133 LVT-1 CLG-1 CTR-1 CLG-2 CRT-1 LVT-1 STOR. RB-1 RB-1 CLG-2 RB-1 CLG-2 ' |RB−1 PT-3 CLG-2 108 CRT-1 LVT-1 PT-2,3 CLG-1 CTR-1&2 |PT-1,2| INSPECTION RB-1 |PT-1 CLG-2 LVT-1 RB-1 PT-3 LVT-1 RB-1 LVT-1,2 1 CLG-2 RB-1 PT-1,2 |PT-1,2| CLG-2 RB-1 PT-3 CLG-2 CLG-2 LVT-1 RB-1 • LVT-1 -|RB-1 RB-1 PT-3 RADIO **102** CLG-2 CLG-2 LVT-1 RB-1 PT-1 CLG-2 RB-1 PT-1 CLG-2 VE

NEW FINISH FLOOR PLAN SCALE: 1/8" = 1'-0"



LOBBY / CORRIDOR PAINT DETAIL

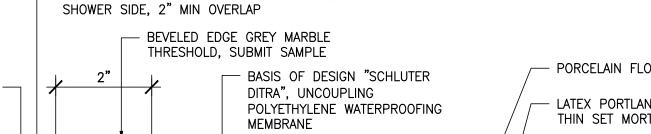

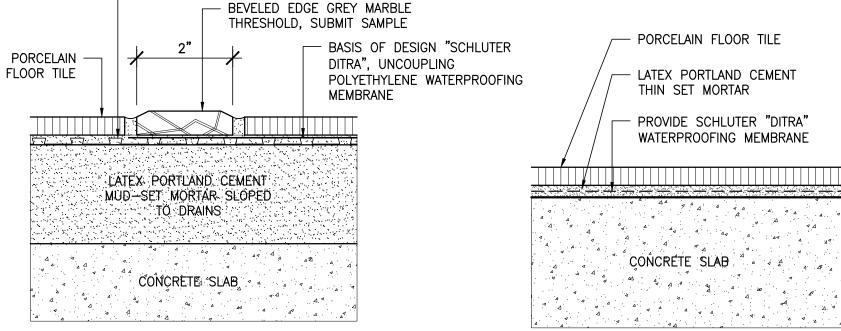


PFT TO PFT (SHOWER MT)


FLOOR TRASITION DETAILS

- BASIS OF DESIGN "SCHLUTER KERDI", SOFT

POLYETHYLENE WATERPROOFING MEMBRANE,

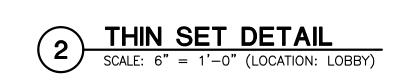

— PORCELAIN OR CERAMIC TILE

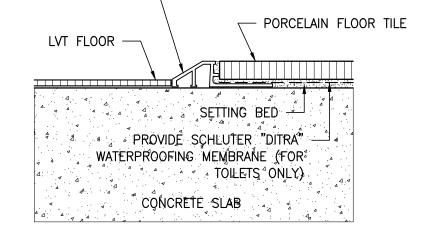


SIMILAR TO "SCHLUTER-RENO-U", METAL

EDGE PROTECTION AND TRANSITION WITH


INTEGRATED JOINT SPACER, OR

PRE-APPPROVED EQUAL

LVT TO PFT

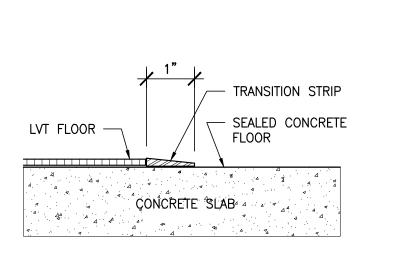

LVT TO SEALED CONC.

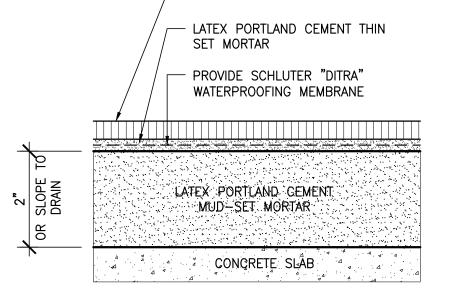


MUD SET DETAIL

CONCRETE SLAB

TRANSITION STRIP

VINYL CARPET EDGE

CARPET TO LVT

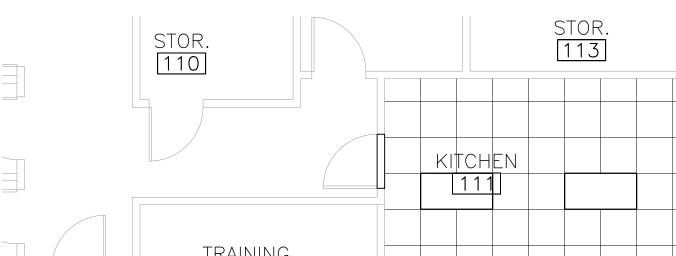

TRAINING OFFICE 108 127 TRAINING ROOM 105

RCP / ELECT. / MECH. PLAN & NOTES

SCALE: 1/8" = 1'-0"

RCP NOTES:

GENERAL CONTRACTOR SHALL COORDINATE THE INSTALLATION AND PROPER LOCATION OF ALL HVAC GRILLES AND LIGHTINGS. CEILING GRID MAYBE SUBJECT TO CHANGE TO ASSURE PROPER CENTERING AND PLACEMENT OF LIGHT FIXTURES IN ROOMS.


FLOOR

- 2. NO ACT (ACOUSTICAL CEILING TILES) TO BE LESS THAN 4" IN EITHER DIRECTION, UNLESS DIRECTED BY THE ARCHITECT.
- 3. CEILING HEIGHTS ARE DERIVED FROM BASE ELEVATION OF THE FINISH FLOOR = 0'-0" UNLESS NOTED OTHERWISE.
- 4. ALL WALL MOUNTED TV'S ARE TO BE BY OWNER, GC TO PROVIDE WOOD BLOCKING AS REQUIRED, CONFIRM MOUNTING HEIGHTS WITH THE OWNER PRIOR TO INSTALLATION
- 5. IN CASE THERE'S A NEED TO ACCESS MECHANICAL DAMPER HANDLES OR OTHER FIRE/PLUMBING CONTROL VALVES IN THE HARD CEILING AREAS, PROVIDE A MINIMUM OF 14"x14" PAINTABLE CEILING ACCESS DOOR.

MECH. & ELECT. NOTES:

- GENERAL CONTRACTOR SHALL COORDINATE THE INSTALLATION AND PROPER LOCATION OF ALL HVAC GRILLES AND LIGHTINGS. CEILING GRID MAYBE SUBJECT TO CHANGE TO ASSURE PROPER CENTERING AND PLACEMENT OF LIGHT FIXTURES IN ROOMS.
- 2. REPLACE MECHANICAL SUPPLY AND RETURNS IN NEW KITCHEN AREA AND NEW OFFICE 135.
- PROVIDE NEW POWER OUTLETS IN OFFICE 135, ONE ON EACH WALL. INSTALL DATA OUTLET AND NEW LIGHT SWITCH IN OFFICE 135.
- 4. PROVIDE NEW POWER OUTLETS IN KITCHEN 111, ONE ON EACH NEW WALL. INSTALL DATA OUTLET AND NEW LIGHT SWITCH IN KITCHEN

RCP ELECT. LEGEND:

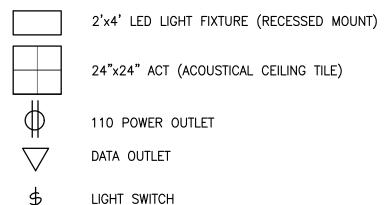

GENERAL NOTES

ALL NOTES APPLY TO ALL DRAWINGS AND ALL TRADES. IT IS THE RESPONSIBILITY OF ALL CONTRACTORS AND TRADES TO COORDINATE THE INSTALLATION OF THEIR WORK WITH THE INSTALLATION OF WORK BY ALL OTHER CONTRACTORS AND TRADES. THE REQUIREMENTS OF THE DRAWINGS, GENERAL REQUIREMENTS AND ALL ITEMS OF THE CONTRACT DOCUMENTS ARE EQUALLY BINDING ON ALL CONTRACTORS AND TRADES. EACH CONTRACTOR IS REQUIRED TO MAINTAIN FULL SETS OF THE CONTRACT DOCUMENTS FOR HIS EMPLOYEES USE ON THE PROJECT TO ASSURE THAT ALL WORK IS PROPERLY COORDINATED AND INSTALLED WITH THE WORK OF OTHER CONTRACTORS AND TRADES.

WHENEVER THERE ARE DISCREPANCIES BETWEEN DRAWINGS, OR BETWEEN THE DRAWINGS AND SPECIFICATIONS, OR CONFLICTS WITHIN THE SPECIFICATIONS AND/OR DRAWINGS. AND SUCH DISCREPANCY IS NOT CALLED TO THI ARCHITECT'S ATTENTION IN TIME TO PERMIT CLARIFICATION BY ADDENDUM, THE CONTRACTOR SHALL BASE HIS BID UPON PROVIDING THE BETTER QUALITY OR GREATER OF WORK OR MATERIAL CALLED FOR, SHALL SUBMIT A WRITTEN STATEMENT WITH HIS PROPOSAL NOTING SUCH DISCREPANCIES, AND SHALL SO FURNISH AND INSTALL SUCH BETTER QUALITY OR GREATER QUANTITY UNLESS OTHERWISE ORDERED IN WRITING.

DATE: 02.29.2024 DRAWN by: jbj CHECKED by: KCN REVISIONS:

1781

Project No.

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YORK, SC FIRE ST JARTERS RENOVAT

Sheet No. 7.10

1. SEE FINISH SCHEDULE AT 7.10 FOR ALL THE FINISH TAG REFERENCE. 2. ALL DOOR & DRAWER FACES TO HAVE ONE VERTICAL GRAIN DIRECTION ONLY.

3. USE HEAVY DUTY RPC-454 5-KNUCKLE DOOR HINGES IN SS FINISH. USE RPC-7036 FOR FOOD LOCKERS.

4. DRAWER SLIDES: USE FULL EXTENSION SLIDES, SEE SPECS.

5. CABINET CATCHES: SEE BELOW IMAGE & SPECS, INSTALL NEAR PULL. 6. IF THERE'S A FINISH TAG DISCREPANCY, GC TO RFI FROM THE ARCHITECT PRIOR TO BID & WORK EXECUTION.



HEAVY DUTY LARGE ROLLER CATCH LATCH, SPRING LOADED (ZINC or SATIN NICKEL FINISH)




1/4" VINYL SLEEVE POLISHED

ALIGN UPPER -





CABINET & DRAWER PULLS SPECS: GLIDERITE HARDWARE 4007-128-SS, 5" NICKEL SHELF SUPPORT PEGS C-to-C (6½" LONG) SOLID EURO BAR PULL (BRUSHED STAINLESS STEEL FINISH)

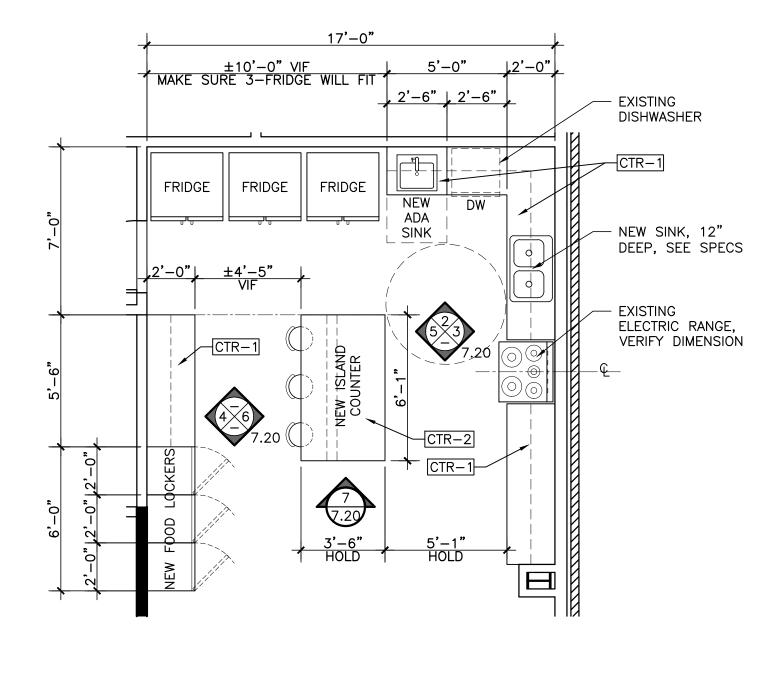


NOTE:
ALL APPLIANCES SHALL BE INSTALLED BY GC (WHETHER SUPPLIED BY OWNER OR NOT, and

NEW OR EXISTING UNITS).

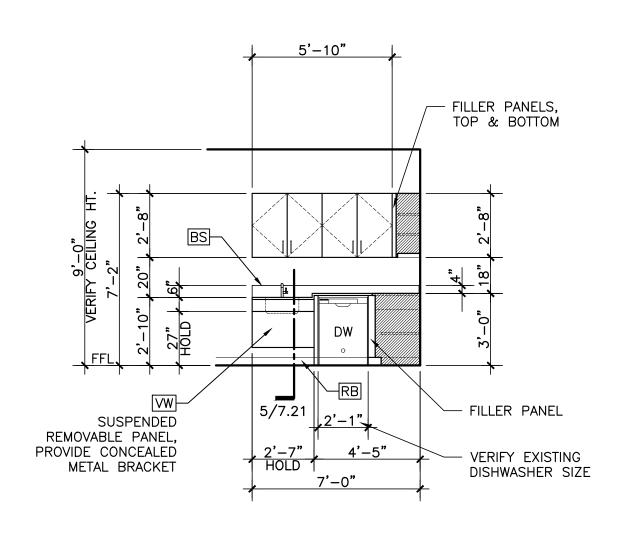

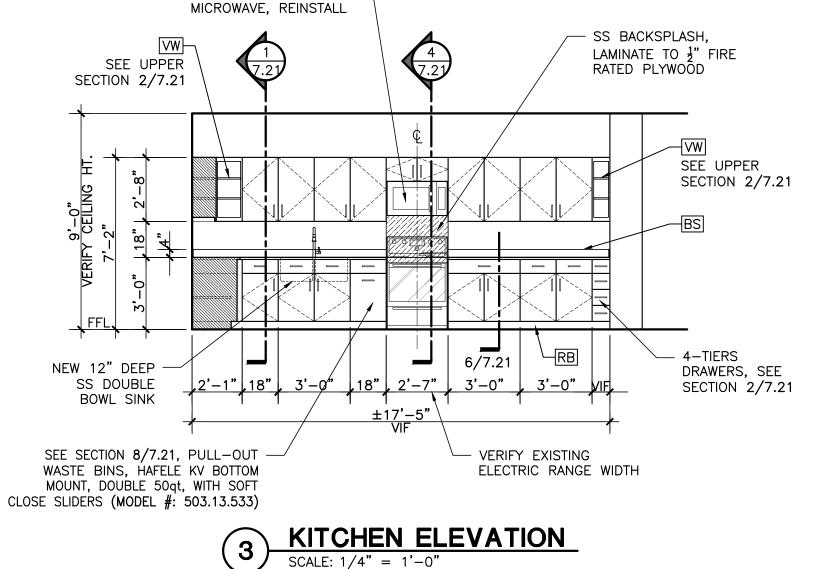


EXISTING OVERHEAD —

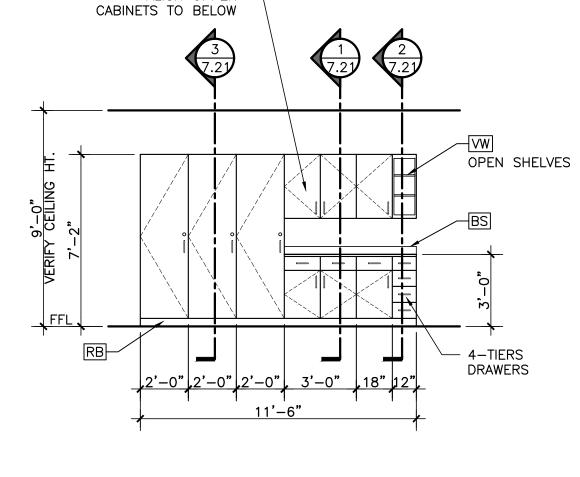

KITCHEN ELEVATION

ENLARGED PLAN @ KITCHEN-111

SCALE: 1/4" = 1'-0"

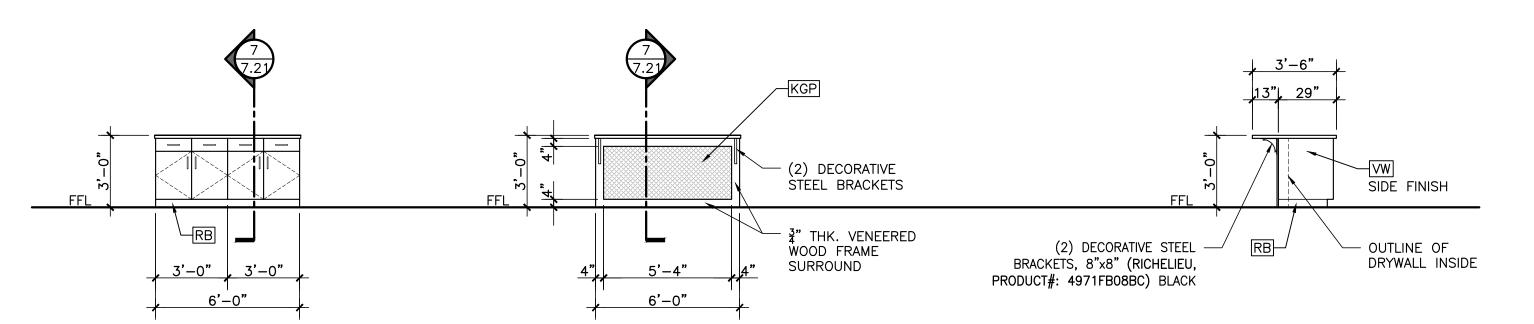

SCALE: 1/4" = 1'-0"

ISLAND COUNTER KITCHEN ELEVATION

SCALE: 1/4" = 1'-0"

ISLAND COUNTER KITCHEN ELEVATION

CASEWORK FINISHES:

CTR-1 COUNTERTOP-1, SOLID SURFACE, WILSONART, DUSK ICE9203CE, 12mm THICK.

CTR-2 COUNTERTOP-2, QUARTZ, WILSONART, LYRA Q2001, 20mm THICK.

VENEERED WOOD, CABINET DOORS & DRAWER FACES (ONE VERTICAL DIRECTION), ARCHITECTURAL WOOD DOORS, SPECIES: RED OAK, COLOR: TO MATCH WOOD DOOR, SUBMIT SET OF STANDARD SAMPLES FOR REVIEW AND APPROVAL, $\frac{3}{4}$ " THICK (U.N.O.).

BS BACKSPLASH, 4" HIGH (U.N.O.), MATERIAL: USE CTR-1 ABOVE.

KGP KNEE GUARD PLATE, DIAMOND LIFE, PLATINUM ICE, SOLID ANODIZED DIAMOND PLATE, COMMERCIAL GRADE AA3003H22. THICKNESS: 0.45" ($\frac{3}{64}$ ", 17GA).

RB RUBBER BASE, SEE SPECS IN FINISH PLAN 7.10.

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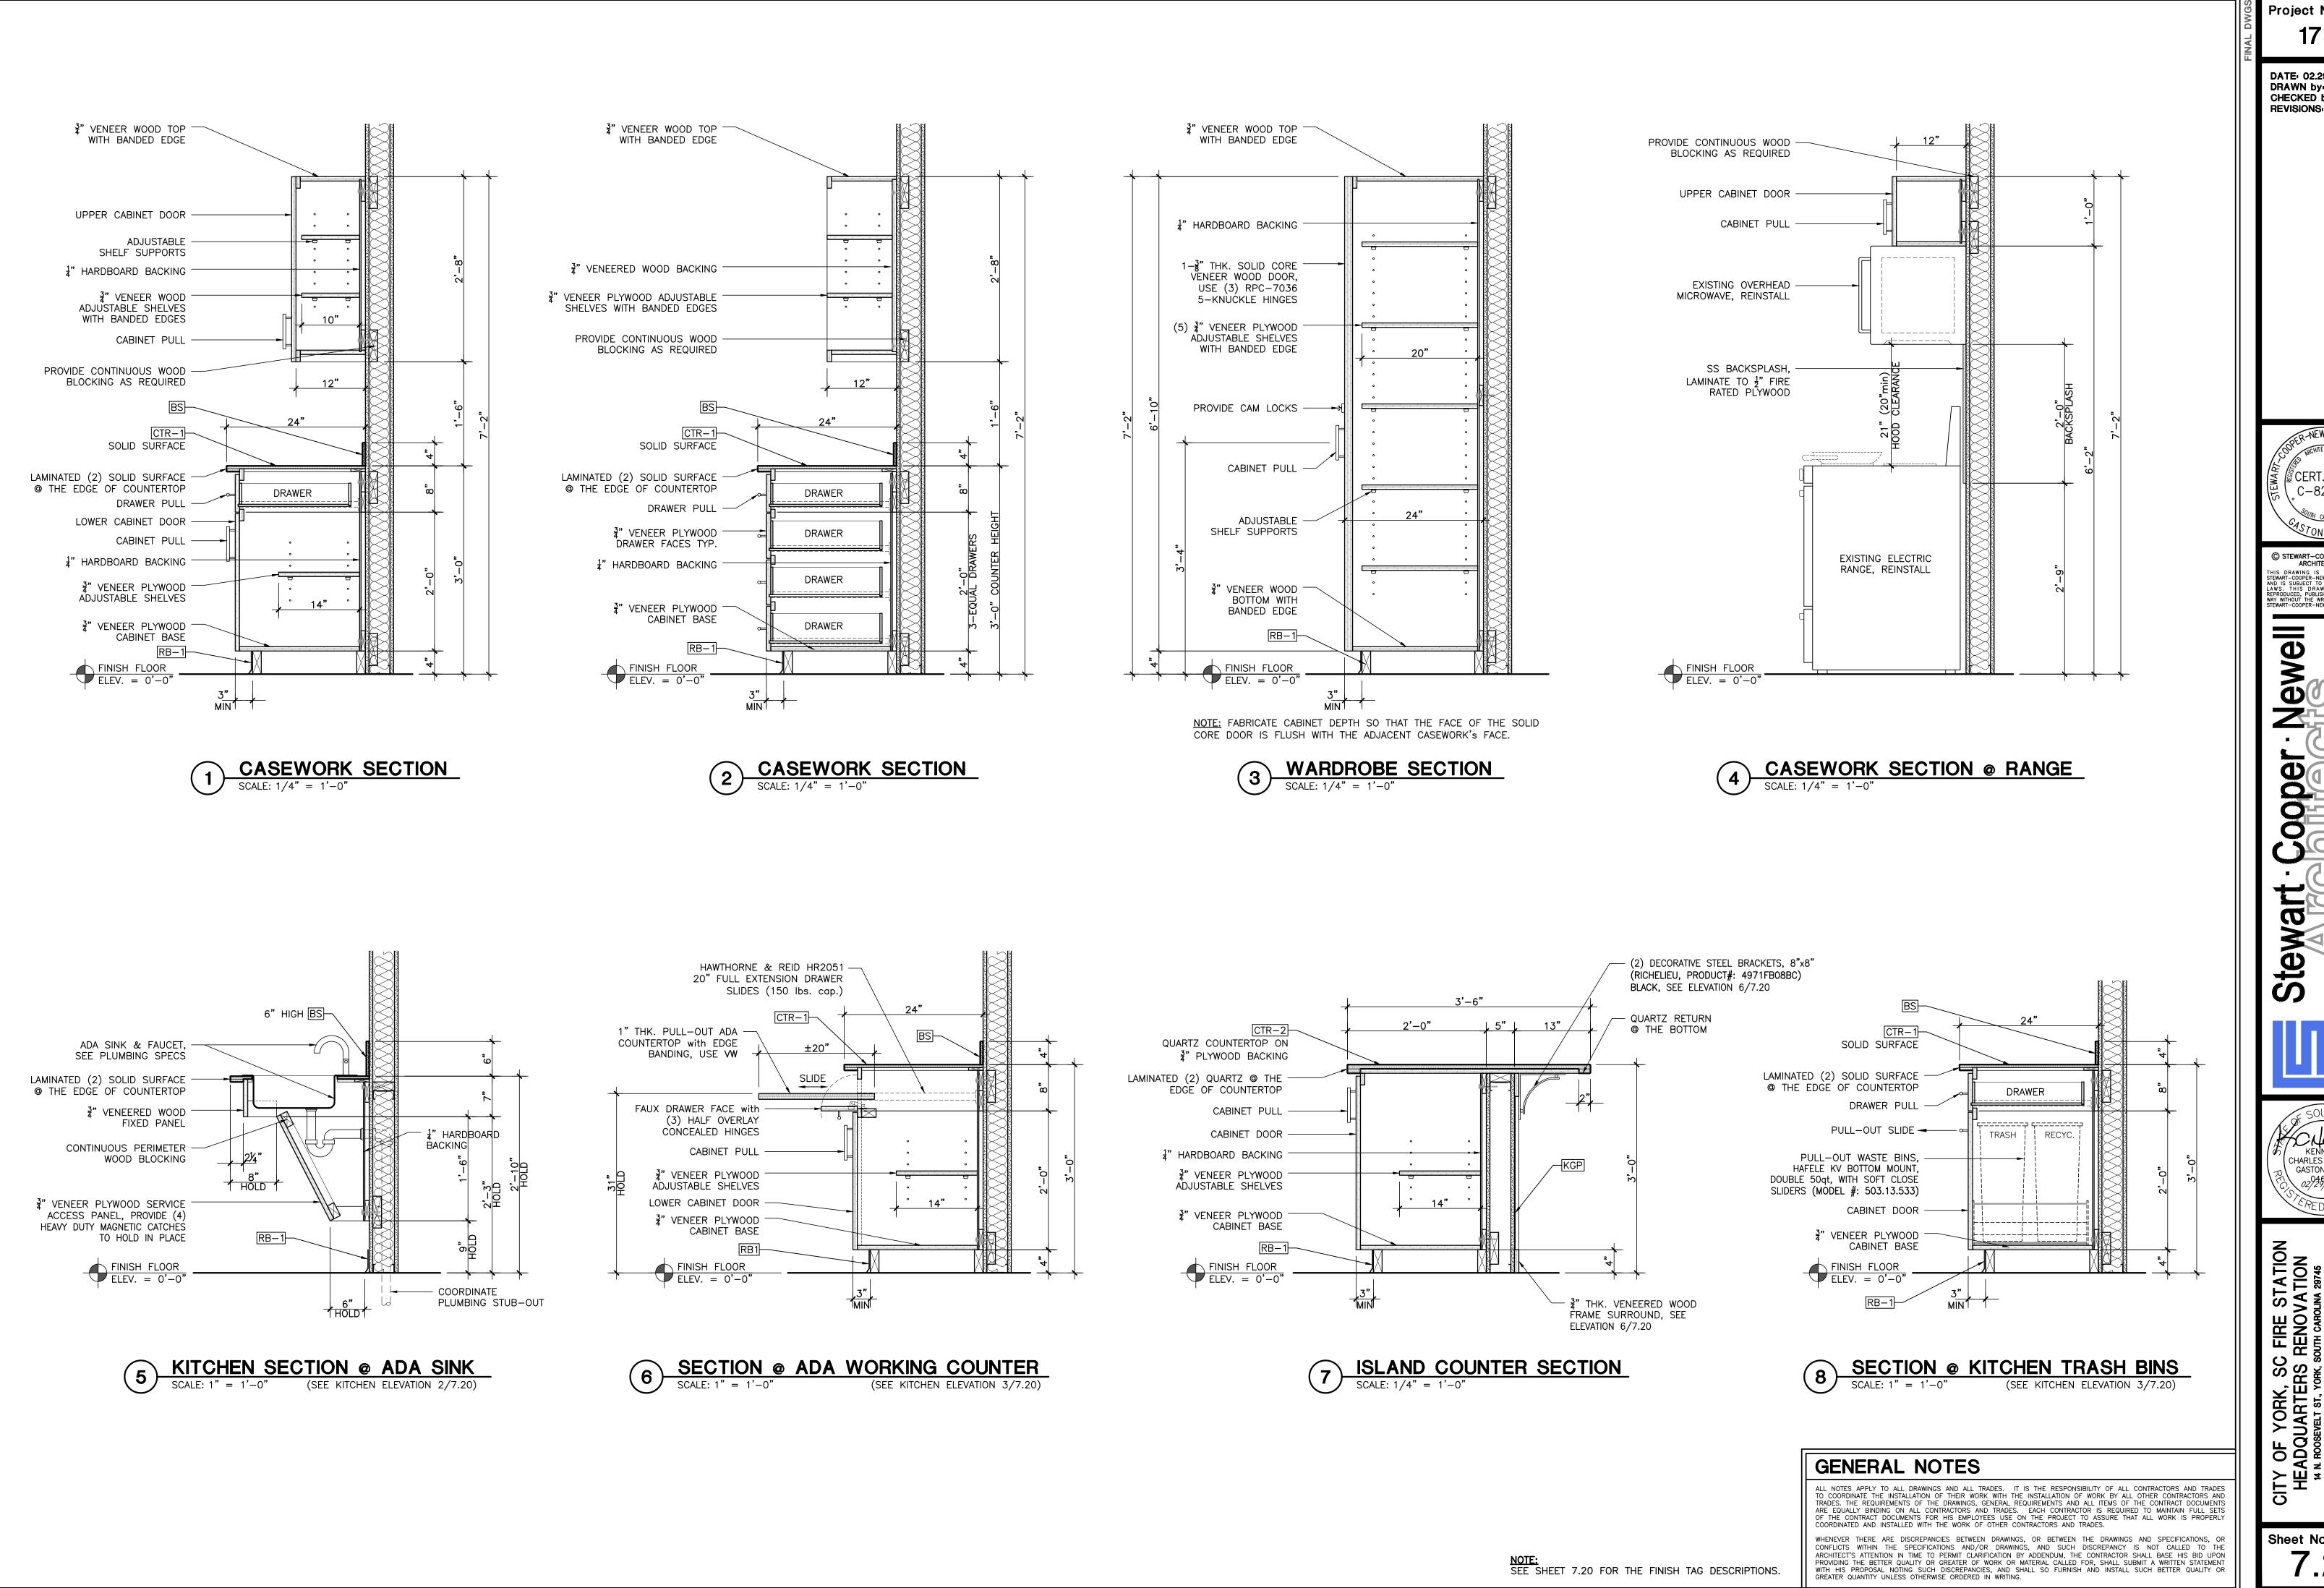
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CHARLES NEWELL GASTONIA, NC 02/29/2024



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Stewart

KENNETH CHARLES NEWELL GASTONIA, NC 02/29/2024